

PROJECT DATA

ZONING: PUD LOT SIZE: 1.565 ACRES (68,189 SF)	ALLOWABLE	EXISTING	PROPOSED
BUILDING DATA	57,960.65 SF (85%)		57,960.65 SF (85%)
GROSS FLOOR AREA:	N/A	N/A	17,943 SF
COVERED OUTDOOR SPACE:	N/A	N/A	2,665.38 SF
PARKING COVERAGE:	N/A	N/A	9,818.88 SF
PARKING LANDSCAPE COVERAGE:	N/A	N/A	0 SF
TOTAL LANDSCAPE COVERAGE:	N/A	N/A	37,761.74 SF
SETBACKS			
FRONT (GOLDEN GATE):	40'-0"	N/A	40'-0"
REAR :	10'-0"	N/A	10'-0"
SIDES (INT.):	5'-0"	N/A	5'-0"
SIDE STREET (CATAMOUNT):	15'-0"	N/A	15'-0"
HEIGHT:	45'-0"	N/A	32'-0"
OFF-STREET PARKING DATA			
RETAIL: 1 SPACE PER 250 SF	10	N/A	10
OFFICE 1 SPACE PER 300 SF	8	N/A	8
WAREHOUSE: 1 SPACE PER EVERY 2 EMPLOYEES	9	N/A	9
TOTAL:	27	N/A	27
OPEN SPACE			
REQUIRED:	10,228.35 SF (15%)		
EXISTING COVERAGE :		N/A	
PROPOSED OPEN SPACE:			17,267.79 SF (25.3%)

SCOPE OF WORK

NEW STEEL FRAMED WAREHOUSE BUILDING

CODE ANALYSIS

- I. JURISDICTION:
CITY OF GOLDEN
- II. ZONING:
PUD
- III. BUILDING CODE:
2015 IBC
2015 INTERNATIONAL ENERGY CODE
ICC/ANSI A117.1-2003 FOR ACCESSIBILITY - UNAMENDED


LEGAL DESCRIPTION

LOT 8
CATAMOUNT SUBDIVISION, FILING NO. 1,
COUNTY OF JEFFERSON
STATE OF COLORADO

ABBREVIATIONS


ABV ABOVE A/C AIR CONDITIONER ADJ ADJACENT ADMIN ADMINISTRATION AFF ABOVE FINISH FLOOR ALT ALTERNATE ALUM ALUMINUM APPROX APPROXIMATE ARCH ARCHITECTURAL AVG AVERAGE AHU AIR HANDLING UNIT BLDG BUILDING B.O. BOTTOM OF CPT CARPET CAB CABINET CL CENTERLINE CLNG CEILING CLR CLEAR CMU CONCRETE MASONRY UNIT CONF CONFERENCE CONT CONTINUOUS CORR CORRIDOR COOR COORDINATE CONC CONCRETE DIA DIAMETER DIM DIMENSION DN DOWN DR DOOR DTL DETAIL DWG DRAWING E.O. EDGE OF EL/ELEV ELEVATION EQ EQUAL EQUIP EQUIPMENT EXST EXISTING F.O. FACE OF FE FIRE EXTINGUISHER	FLR FLOOR FURN FURNITURE GA GAUGE GALV GALVANIZED GWB GYPSUM WALL BOARD GL GLASS GYP BRD GYPSUM BOARD HP HIGH POINT HDW HARDWARE INT INTERIOR JAN JANITOR JT JOINT JUNC JUNCTION KP KEY PAD LAB LABORATORY LAM LAMINATED LAV LAVATORY L.P. LOW POINT MAT MATERIAL MAX MAXIMUM MECH MECHANICAL MEZZ MEZZANINE MFR MANUFACTURER MGR MANAGER MISC MISCELLANEOUS MIN MINIMUM MTL METAL NIC NOT IN CONTRACT NTS NOT TO SCALE NOM NOMINAL OC ON CENTER OPNG OPENING OPP OPPOSITE PL PLASTIC LAMINATE PLAM PLASTIC LAMINATE PLYWD PLYWOOD	PTD PAINTED QTY QUANTITY RAD RADIUS REF REFRIGERATOR REQ REQUIRED REV REVISION/REVISED RM ROOM RO ROUGH OPENING SAN SANITARY SCHED SCHEDULE SF SQUARE FOOT SIM SIMILAR SPECS SPECIFICATIONS SQFT SQUARE FOOT SS STAINLESS STEEL STD STANDARD STK STACK STOR STORAGE SW SWITCH T.O. TOP OF T.O.S. TOP OF SLAB TV TELEVISION TYP TYPICAL UON UNLESS OTHERWISE NOTED USS UNDER SIDE OF SLAB VCT VENT, COMPOSITION TILE VENT VENTILATION VERT VERTICAL VVY VVVY WALLCOVERING VEST VESTIBULE VIF VERIFY IN FIELD W/ WALLCOVERING WC WOOD WKS WORKSTATION W/O WITHOUT WP WALL PANEL
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LOCATION MAP

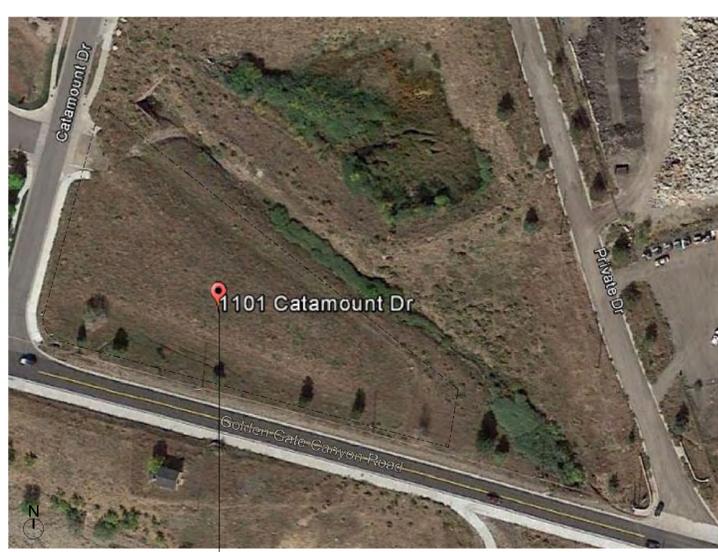

JOB ADDRESS:
1101 Catamount Drive
Golden, Colorado 80403

SET OUT PLAN

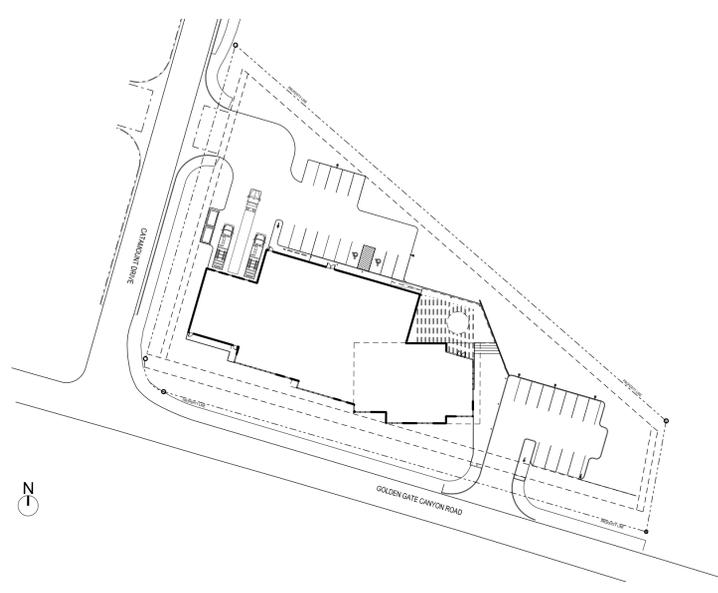

1 SET OUT PLAN
SCALE: NTS

DRAWING INDEX

DRAWING PLAN	DATE	REVISIONS
COVER		
ARCHITECTURAL		
A-001 PROJECT DATA/SUSTAINABILITY MENU	●	
A-100 SITE MAP	●	
A-200 ELEVATIONS	●	
LANDSCAPE		
L-1 PLANTING PLAN	●	
MEP		
E-1 LIGHTING PLAN	●	
CIVIL		
C-1 SITE PLAN	●	
C-2 GRADING PLAN	●	

MATERIAL SELECTION*

GL-1 STOREFRONT GLAZING SYSTEM MANUF: GALV COLOR: GALV LOCATION: SEE ELEVATIONS A-200	VENDOR: FINISH: SMOOTH
M-1 INSULATED METAL PANEL MANUF: GALV SERIES/MODEL#: GALV LOCATION: SEE ELEVATIONS A-200	VENDOR: FINISH: CHARCOAL
S-1 SPLIT-FACE BLOCK MANUF: GALV SERIES/MODEL#: GALV LOCATION: SEE ELEVATION A-200	VENDOR: FINISH:
WD-1 WOODEN TRELLIS BEAMS MANUF: GALV SERIES/MODEL#: GALV LOCATION: SEE ELEVATION A-200	VENDOR: FINISH:

*PRELIMINARY MATERIAL SELECTIONS PENDING OWNER APPROVAL

SUSTAINABILITY MENU

POINTS	MENU ITEM
4	WATER CONSERVATION STORMWATER AND QUALITY 1. EMPLOY STORM WATER RUNOFF REDUCTION STRATEGIES TO SLOW RUNOFF AND PROMOTE INFILTRATION. ONE POINT IS AWARDED FOR EVERY 20% IMPERVIOUS AREA ROUTED THROUGH BIOSWALES, BIOBUFFERS, RAIN GARDENS AND/OR PERMEABLE PAVEMENT DESIGNED IN ACCORDANCE WITH THE CITY OF GOLDEN STORMWATER STANDARDS MANUAL.
1	2. PLANT A VEGETATED ROOF FOR A PORTION OF THE ROOF AREA. POINTS AWARDED ON A SLIDING SCALE, WITH ONE POINT FOR EVERY TEN PERCENT OF VEGETATED ROOF AREA.
2	3. EXCEED OPEN SPACE REQUIREMENT BY 25% OR MORE. INCLUDES BOTH LANDSCAPED AND XERISCAPED AREAS.
3	4. USE WATER CONSERVATION MEASURES, INCLUDING SUB 1-GALLON FLUSH URINALS, DUAL FLUSH TOILETS, LOW FLOW FAUCETS AND SHOWERHEADS, DRIP IRRIGATION WITH RAIN SENSORS AND INDUSTRIAL CONSERVATION MEASURES.
	TRANSPORTATION
3	5. PROVIDE DOUBLE THE MINIMUM OF THE REQUIRED AMOUNT OF BICYCLE PARKING ON SITE FOR ONE POINT. ONE ADDITIONAL POINT FOR PROVIDING A BIKE REPAIR STATION, AND ONE ADDITIONAL POINT FOR PROVIDING SECURE AND ENCLOSED PARKING (E.G. LOCKERS, STORAGE ROOM) FOR AT LEAST 50 PERCENT OF THE BIKE PARKING NEEDED FOR DOUBLE THE MINIMUM AMOUNT.
1	6. PROVIDE NUMBER OF SHOWER UNITS FOR MINIMUM OF TWO PERCENT OF ALL FULL TIME EQUIVALENT EMPLOYEES
3	7. INSTALL LEVEL 2 (240 VOLT) OR GREATER ELECTRIC PLUG-IN STATIONS FOR HYBRID AND ELECTRIC VEHICLES FOR THREE PERCENT OF THE TOTAL VEHICLE PARKING SPACES ON SITE FOR TWO POINTS, AND MAKE THEM AVAILABLE TO THE GENERAL PUBLIC FOR ONE ADDITIONAL POINT.
3	8. RESTRICT PARKING ON SITE TO THE MINIMUM NUMBER OF SPACES ALLOWED BY CODE. CAR SHARE SPACES SHALL REDUCE THE REQUIRED MINIMUM SPACES BY A 1:1 RATIO. ONLY STANDARD AISLES AND SPACES ALLOWED UNLESS UNDER EXCLUSIVE EASEMENT.
	ENERGY EFFICIENCY
5	9. INCREASE ENERGY EFFICIENCY OF STRUCTURE OVER CURRENTLY ADOPTED IECC CODE REQUIREMENT. POINTS ARE AWARDED ON A SLIDING SCALE WITH ONE POINT FOR EVERY TWO PERCENT INCREASE IN ENERGY EFFICIENCY. UP TO 25 POINTS. POINTS MAY BE AWARDED FOR EFFICIENCY GAINS IN SPECIFIC SYSTEMS, SUCH AS LIGHTING OR MECHANICAL, BUT MORE POINTS MAY BE AWARDED FOR AN INTEGRATED DESIGN APPROACH.
3	10. INSTALL BUILDING AUTOMATION SYSTEMS FOR ADVANCED MONITORING, WHICH CAN INCLUDE NETWORKED CONTROLS OF MULTIPLE BUILDING SYSTEMS, SUCH AS HEATING AND COOLING, VENTILATION, DAYLIGHTING AND LIGHTING.
3	11. PLANT AT LEAST 20 PERCENT ADDITIONAL TREES THAN OTHERWISE REQUIRED TO MAXIMIZE SHAD OVER PAVED OR COVERED AREAS IN SUMMER (DECIDUOUS EAST, WEST, SOUTH) PROVIDE A WIND BREAK IN WINTER (EVERGREENS TO THE NORTH) AND REDUCE THE URBAN HEAT ISLAND EFFECT IN PARKING AREAS AND THROUGHOUT THE SITE.
3	12. CONSTRUCT PREDOMINANTLY RESIDENTIAL BUILDINGS AND/OR ROOFS TO BE ELONGATED ON AN EAST/WEST AXIS, WITH SOUTH FACING WINDOWS THAT RECEIVED SUNLIGHT BETWEEN THE HOURS OF 9:00 A.M. AND 3:00 P.M. (SUN EXPOSURE) DURING THE HEATING SEASON. THIS SHALL BE COUPLED WITH THE USE OF AWNINGS OR OTHER SHAD STRUCTURES ON THE EAST AND WEST FACING WINDOWS. APPROPRIATE USE OF GLAZING, USE OF DAYLIGHTING, AND OTHER PASSIVE SOLAR DESIGN TECHNIQUES TO REDUCE ENERGY DEMAND, INCLUDING BUILDING ENVELOPE DESIGN.
2	13. INSTALL HEAT REFLECTIVE ROOF MATERIALS. MINIMUM 29 SRI (SOLAR REFLECTIVE INDEX) MATERIALS QUALIFY.
36	TOTAL

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POWDER 7 WAREHOUSE

1101 CATAMOUNT DRIVE
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REVISIONS

DATE	REVISION
07/07/2017	DEVELOPMENT REVIEW




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1 SITE MAP
SCALE : 1" = 20'-0"

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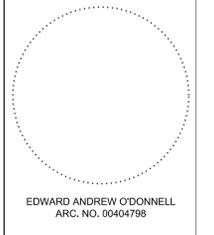
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REVISIONS

NO.	DATE	DESCRIPTION
07/07/2017	DEVELOPMENT REVIEW	

NOT FOR CONSTRUCTION
(DEVELOPMENT PLAN REVIEW)

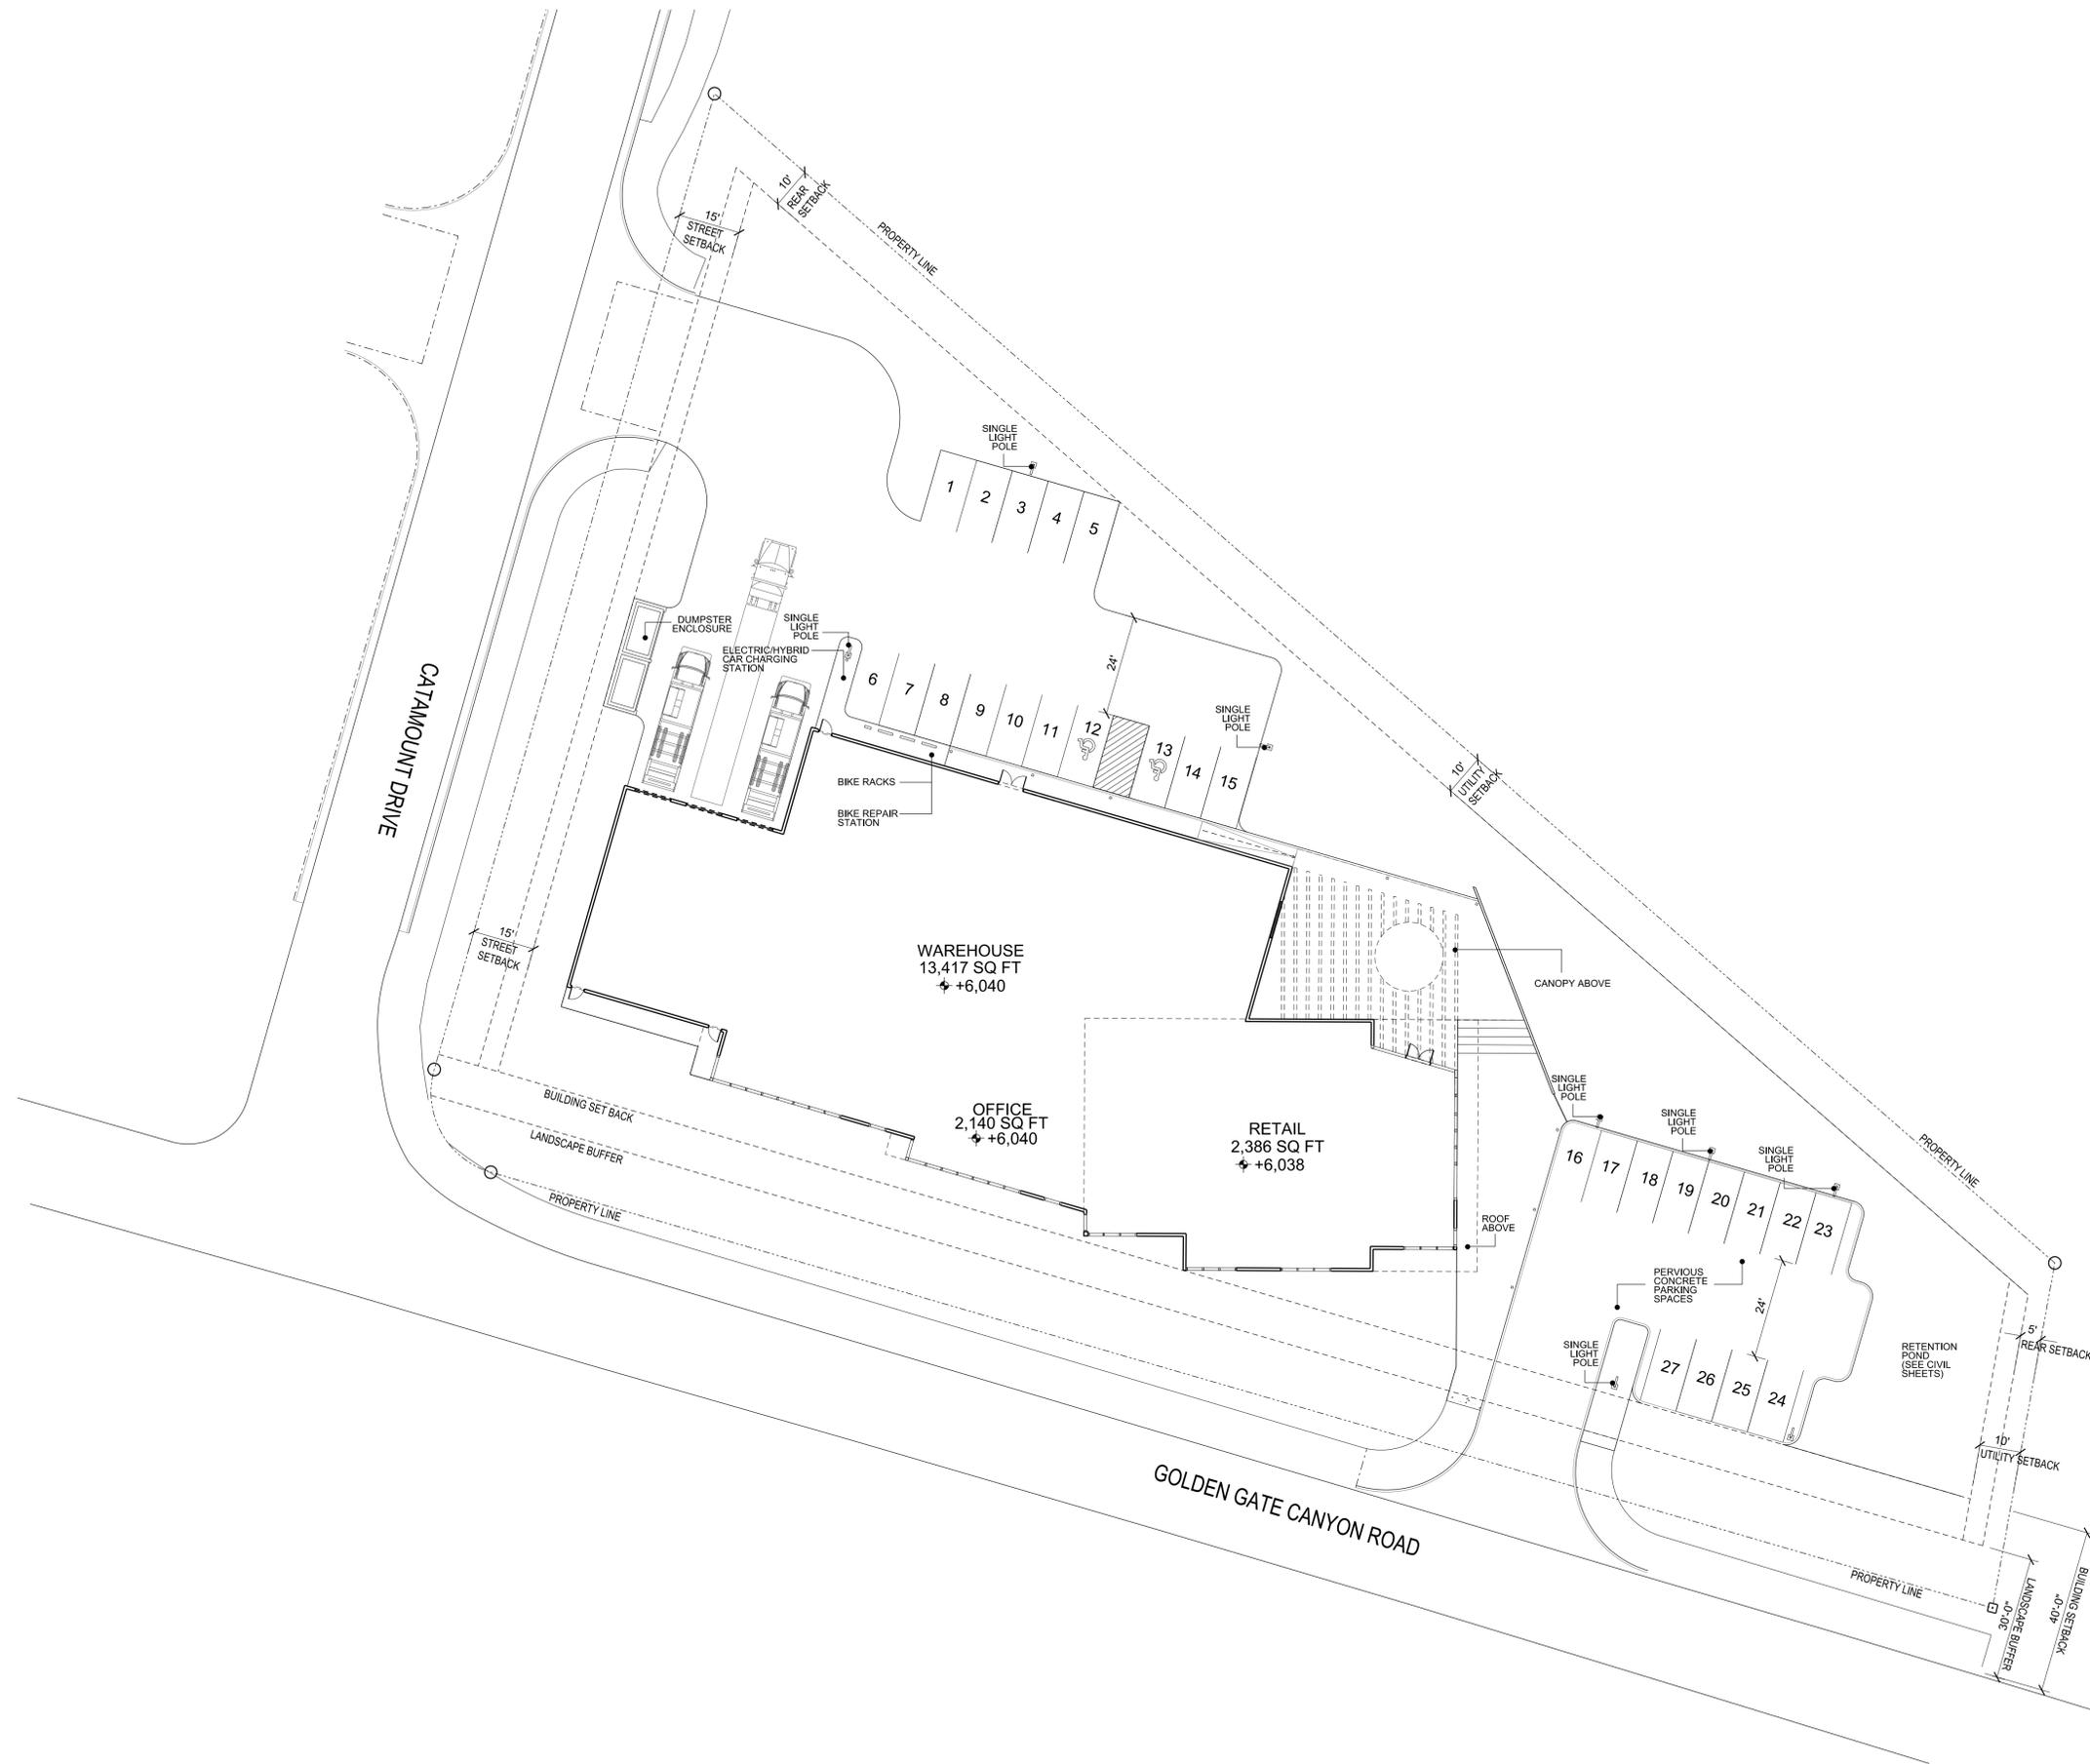


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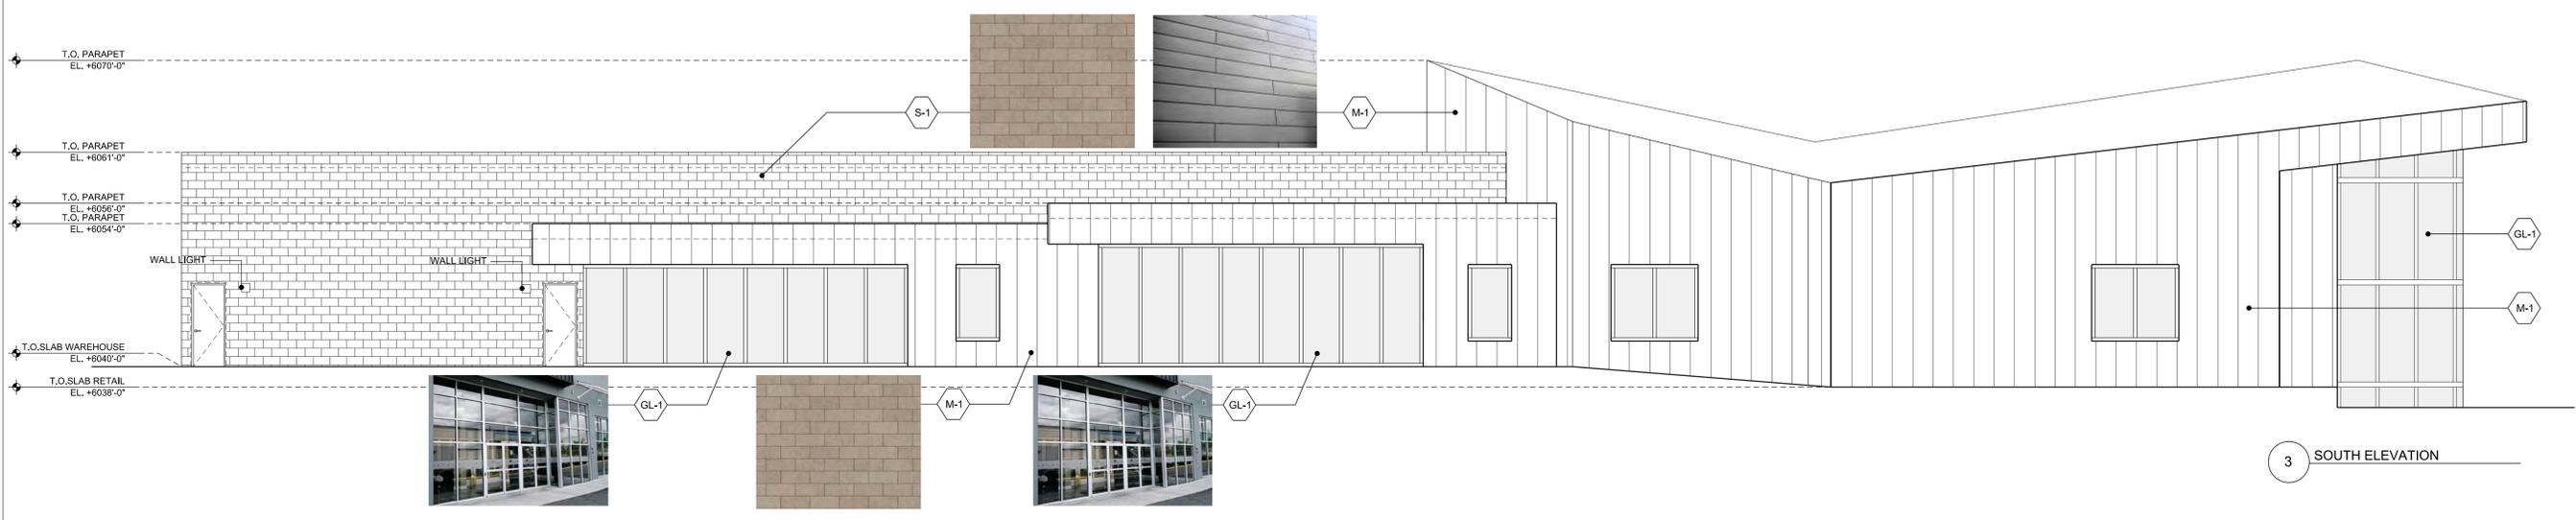
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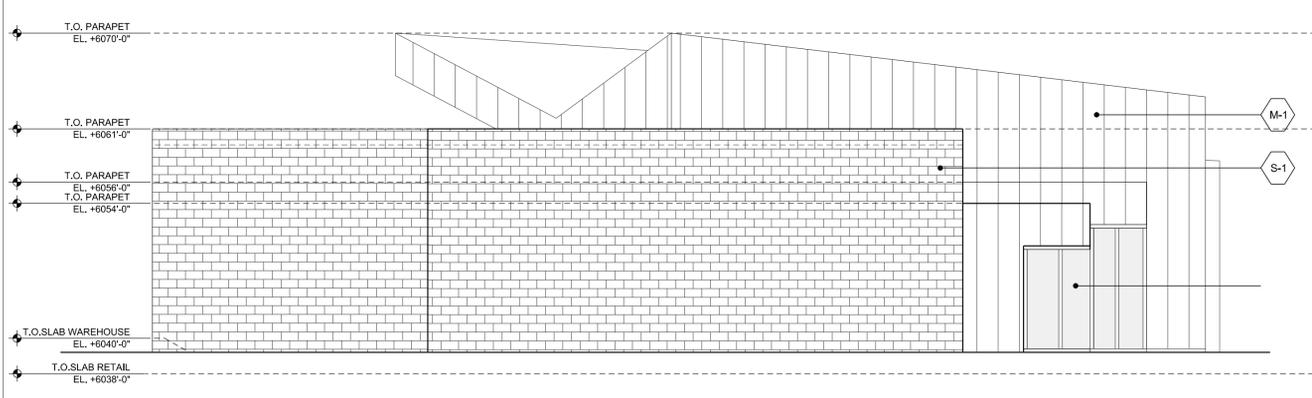
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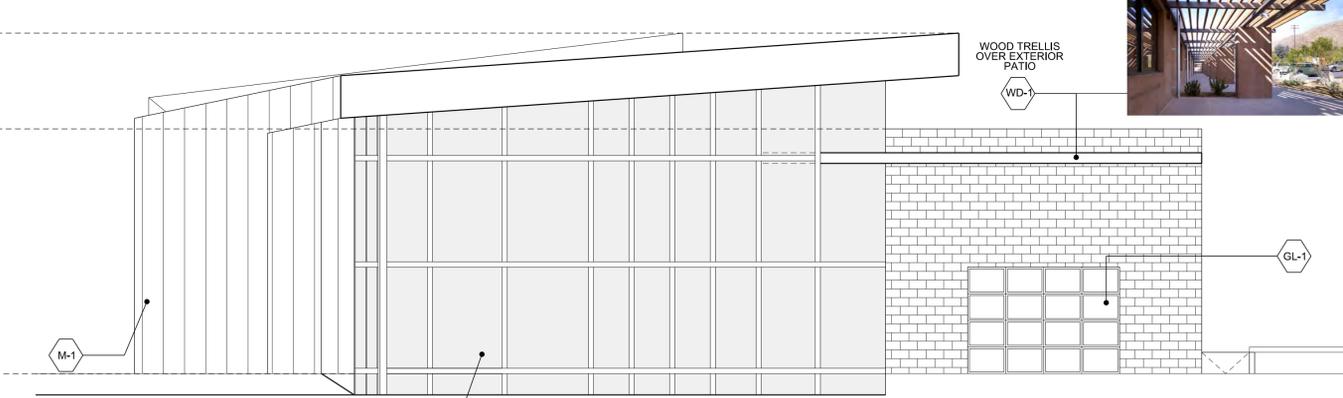
4 NORTH ELEVATION



3 SOUTH ELEVATION

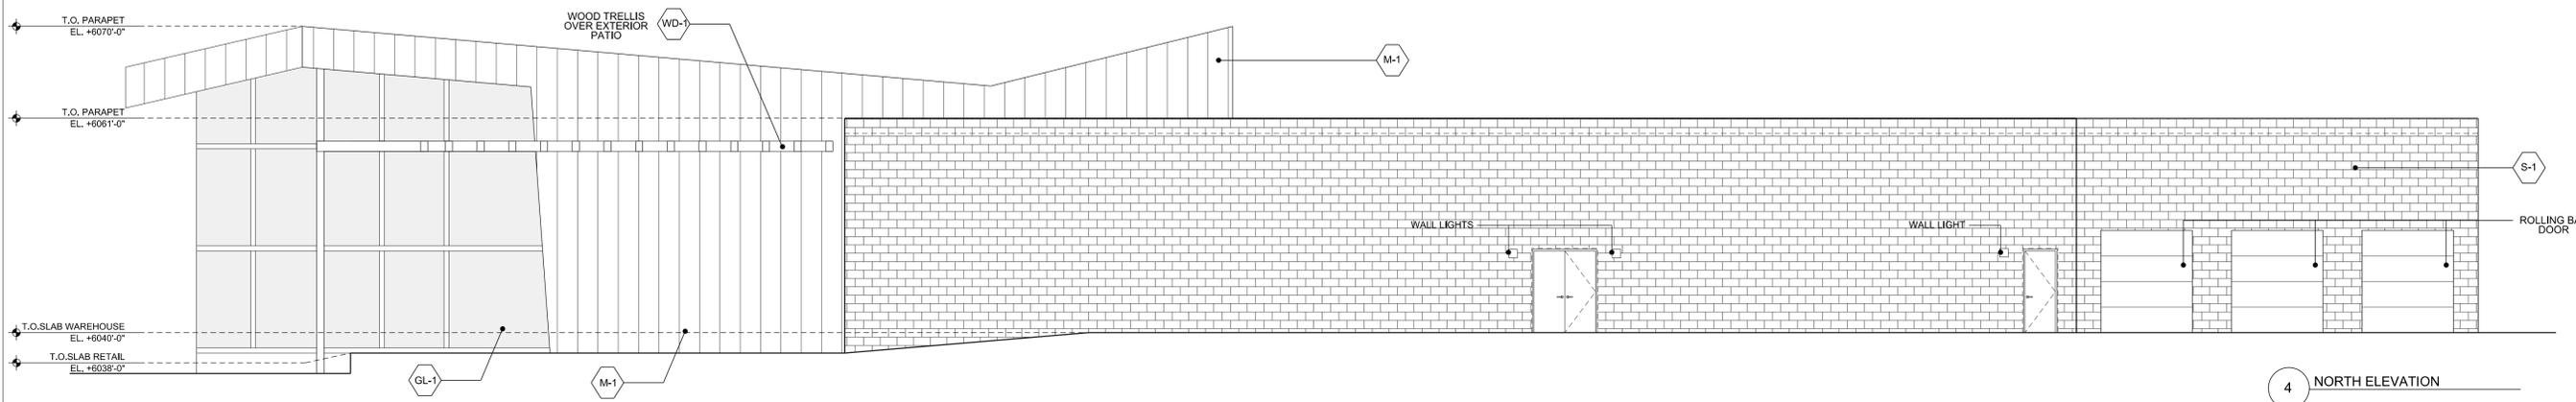

2 WEST



1 EAST ELEVATION

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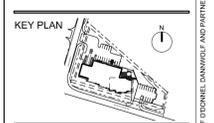
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REVISIONS

DATE	REVISION
07/07/2017	DEVELOPMENT REVIEW

WOOD TRELLIS INSPIRATIONS

NOT FOR CONSTRUCTION
 (DEVELOPMENT PLAN REVIEW)



SCALE: 1/8" = 1' - 0"
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 ELEVATIONS

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LANDSCAPE PLANT LIST

DECIDUOUS SHADE TREES						
SYMBOL	COMMON NAME	BOTANICAL NAME	MATURE HEIGHT	MATURE SPREAD	WATER USE	SUN/SHADE
WEH	Western Hackberry	Celtis occidentalis	50-60'	40-50'	Low	Sun
SHL	Shademaster Honeylocust	Gleditsia triacanthos inermis 'Shademaster'	40-50'	30-40'	Low	Sun
GRL	Greenspire Linden	Tilia cordata 'Greenspire'	30-40'	25-35'	Medium	Sun
BUO	Bur Oak	Quercus macrocarpa	50-80'	50-80'	Low	Sun

ORNAMENTAL TREES						
SYMBOL	COMMON NAME	BOTANICAL NAME	MATURE HEIGHT	MATURE SPREAD	WATER USE	SUN/SHADE
BTM	Bigtooth Maple	Acer grandidentatum	20-30'	20-30'	Low	Sun
EAR	Eastern Redbud	Cercis canadensis	20-30'	20-30'	Medium	Shade / Part Shade
RUH	Russian Hawthorn	Crataegus ambigua	15-25'	20'	Low	Sun

EVERGREEN TREES						
SYMBOL	COMMON NAME	BOTANICAL NAME	MATURE HEIGHT	MATURE SPREAD	WATER USE	SUN/SHADE
RMJ	Rocky Mountain Juniper	Juniperus scopulorum	20-30'	8-12'	Very Low	Sun
AUS	Austrian Pine	Pinus nigra	40-60'	30-40'	Low	Sun
PRP	Ponderosa Pine	Pinus ponderosa	60-80'	30-40'	Low	Sun

DECIDUOUS SHRUBS						
SYMBOL	COMMON NAME	BOTANICAL NAME	MATURE HEIGHT	MATURE SPREAD	WATER USE	SUN/SHADE
OCJ	Orange Columar Japanese Barberry	Berberis thunbergii 'Orange Rocket'	4-5'	18-24"	Low	Sun / Part Shade
SFB	Silver Fountain Bittersweet	Buddleja alternifolia 'Argentea'	10-15'	10-15'	Low	Sun
BMS	Blue Mist Spirea	Caryopteris x clarnensis 'Blue Mist'	3-4'	2-3'	Low	Sun
LMM	Littleleaf Mountain Mahogany	Cercocarpus intricatus	6-8'	4-6'	Very Low	Sun / Part Shade
FEB	Fernbush	Chamaebotrys millefolium	3-5'	3-4'	Very Low	Sun
SGB	Spanish Gold Broom	Cytisus purgans Spanish Gold	2-4'	4-6'	Low	Sun
RUS	Russian Sage	Perovskia arvensis	3-4'	3-4'	Very Low	Sun
RMR	Red Meiland Rose	Rosa Meiland Red	15-24"	4-6"	Low	Sun

EVERGREEN SHRUBS						
SYMBOL	COMMON NAME	BOTANICAL NAME	MATURE HEIGHT	MATURE SPREAD	WATER USE	SUN/SHADE
PMZ	Panchito Manzanita	Arctostaphylos x coloradensis 'Panchito'	10-15'	3-5'	Low	Sun / Part Shade
BLE	Blondy Euonymus	Euonymus fortunei Blondy	18-24"	1-2'	Medium	Part Shade / Shade
REY	Red Faber (Texas) Yucca	Hesperaloe parviflora	3-4'	3-4'	Very Low	Sun
ARJ	Arreton Juniper	Juniperus chinensis 'Arretongi'	3-4'	3-4'	Low	Sun
OGH	Oregon Grape Holly	Mahonia aquifolium	4-6'	4-6'	Low	Shade
WBM	White Bud Mugo Pine	Pinus mugo 'White Bud'	2-3'	3-4'	Low	Sun / Part Shade
BEY	Bright Edge Yucca	Yucca filamentosa 'Bright Edge'	2-3'	2-4'	Low	Sun / Part Shade

ORNAMENTAL GRASSES						
SYMBOL	COMMON NAME	BOTANICAL NAME	MATURE HEIGHT	MATURE SPREAD	WATER USE	SUN/SHADE
VFR	Vaselet Feather Reed Grass	Calamagrostis acutiflora 'Avalanche'	3-4'	18-24"	Low	Sun / Part Shade
GJF	Golden Japanese Forest Grass	Hakonechloa macra 'Aureola'	15-18"	15-20"	Medium	Shade
BAG	Blue Avena Grass	Helictotrichon sempervirens	2-2'	18-24"	Low	Sun
MFG	Mexican Feather Grass	Nassella tenuissima	2-2'	1-2'	Low	Sun
SRS	Shenandoah Red Switch Grass	Panicum virgatum 'Shenandoah'	3-4'	12-18"	Low	Sun


PERENNIALS						
SYMBOL	COMMON NAME	BOTANICAL NAME	MATURE HEIGHT	MATURE SPREAD	WATER USE	SUN/SHADE
PPY	Paprika Red Yarrow	Achillea millefolium 'Paprika'	18-24"	18-24"	Low	Sun
SMS	Silver Mound Sage	Artemisia schmidtiana	12-18"	18-24"	Low	Sun
DDC	Dwarf Double Coreopsis	Coreopsis grandiflora 'Sunray'	12-18"	12-18"	Low	Sun
PIP	Purple Inloplant	Delosperma cooperi	2-4"	12-18"	Low	Sun
PCF	Purple Coneflower	Echinacea purpurea	2-3'	18-24"	Low	Sun
BGD	Ballerina Grayleaf Cranesbill	Geranium cheirum 'Ballerina'	6-8"	12-15"	Medium	Adaptable
AWC	Avalanche White Dwarf Sun Daisy	Osteospermum 'Avalanche'	10-12"	12-15"	Low	Sun / Part Shade
FUR	Furman's Red Salvia	Salvia greggii 'Furman's Red'	2-3'	2-3'	Low	Sun

LARGE PERENNIALS

LOW PERENNIALS & GROUNDCOVERS




SOD
 90/10 Fescue/Bluegrass Mix


NATIVE SEEDING - DRYLAND MIX
 Pawnee Buttes Seed Mixes (www.pawneebuttesseed.com);
 PBSI Low Grow Mix
 Application Rate: 5 LBS/1,000 SF

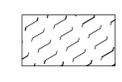
NATIVE SEEDING - WETLAND MIX
 Pawnee Buttes Seed Mixes (www.pawneebuttesseed.com);
 PBSI Prairie Wetland Mix
 Application Rate: 10 LBS/Acre


GENERAL LANDSCAPE NOTES

- ALL LOW PERENNIAL AND GROUND COVER PLANTING AREAS SHALL BE MULCHED WITH SHREDDED WESTERN RED CEDAR WOOD MULCH, AT A DEPTH OF 3". WEED BARRIER FABRIC IS NOT REQUIRED UNDER WOOD MULCH.
- ALL OTHER PLANTING BED AREAS SHALL BE MULCHED WITH 1-1/2" WESTERN RIVER ROCK, AT A DEPTH OF 3", INSTALLED OVER PERMEABLE WEED BARRIER FABRIC. DO NOT INSTALL EDGING BETWEEN WOOD MULCH AND ROCK MULCH AREAS.
- SOD EDGER SHALL BE 14 GAUGE ROLLED TOP STEEL EDGING (DARK GREEN COLOR) IN THE LOCATIONS SHOWN ON THE PLANS. EDGER IS NOT REQUIRED WHERE SOD ABUTS CONCRETE.
- ALL AREAS TO BE LANDSCAPED SHALL HAVE ORGANIC AMENDMENTS THOROUGHLY INCORPORATED INTO THE SOIL AT A RATE OF 5 CUBIC YARDS PER 1,000 SQUARE FEET, AND TILLED TO A DEPTH OF 6 INCHES.
- ALL SOD AREAS, BED AREAS, AND LANDSCAPE AREAS SHALL BE FINE GRADED PRIOR TO INSTALLATION OF NEW PLANT MATERIAL. ROCKS, WOOD, AND ANY MATERIAL LARGER THAN 1" IN DIAMETER SHALL BE REMOVED FROM ALL PLANTING AREAS PRIOR TO SODDING AND PLANTING NEW MATERIALS.
- EXISTING TURF, SHRUBS, TREES, AND PLANT MATERIAL TO BE REMOVED SHALL BE FULLY REMOVED FROM THE SITE, INCLUDING ALL ROOTS.
- ALL LANDSCAPED AREAS SHALL BE WATERED BY A FULLY AUTOMATIC UNDERGROUND IRRIGATION SYSTEM.
- SOD AREAS SHALL BE ZONED SEPARATELY THAN BEDS, AND SHALL BE IRRIGATED VIA POP-UP SPRAY HEADS PROVIDING FULL (HEAD TO HEAD) COVERAGE. HEADS SHALL BE COMMERCIAL GRADE WITH REPLACEABLE NOZZLES, PRESSURE REGULATORS, AND CHECK VALVES.
- BED AREAS SHALL BE ZONED SEPARATELY THAN SOD AREAS, AND SHALL BE IRRIGATED BY INDIVIDUAL DRIP EMITTERS TO EACH PLANT. DRIP COMPONENTS SHALL BE COMMERCIAL GRADE RAIN-BIRD OR EQUAL POINT SOURCE EMITTERS, WITH ALL PLANTS RECEIVING IRRIGATION.

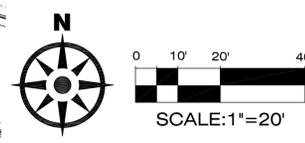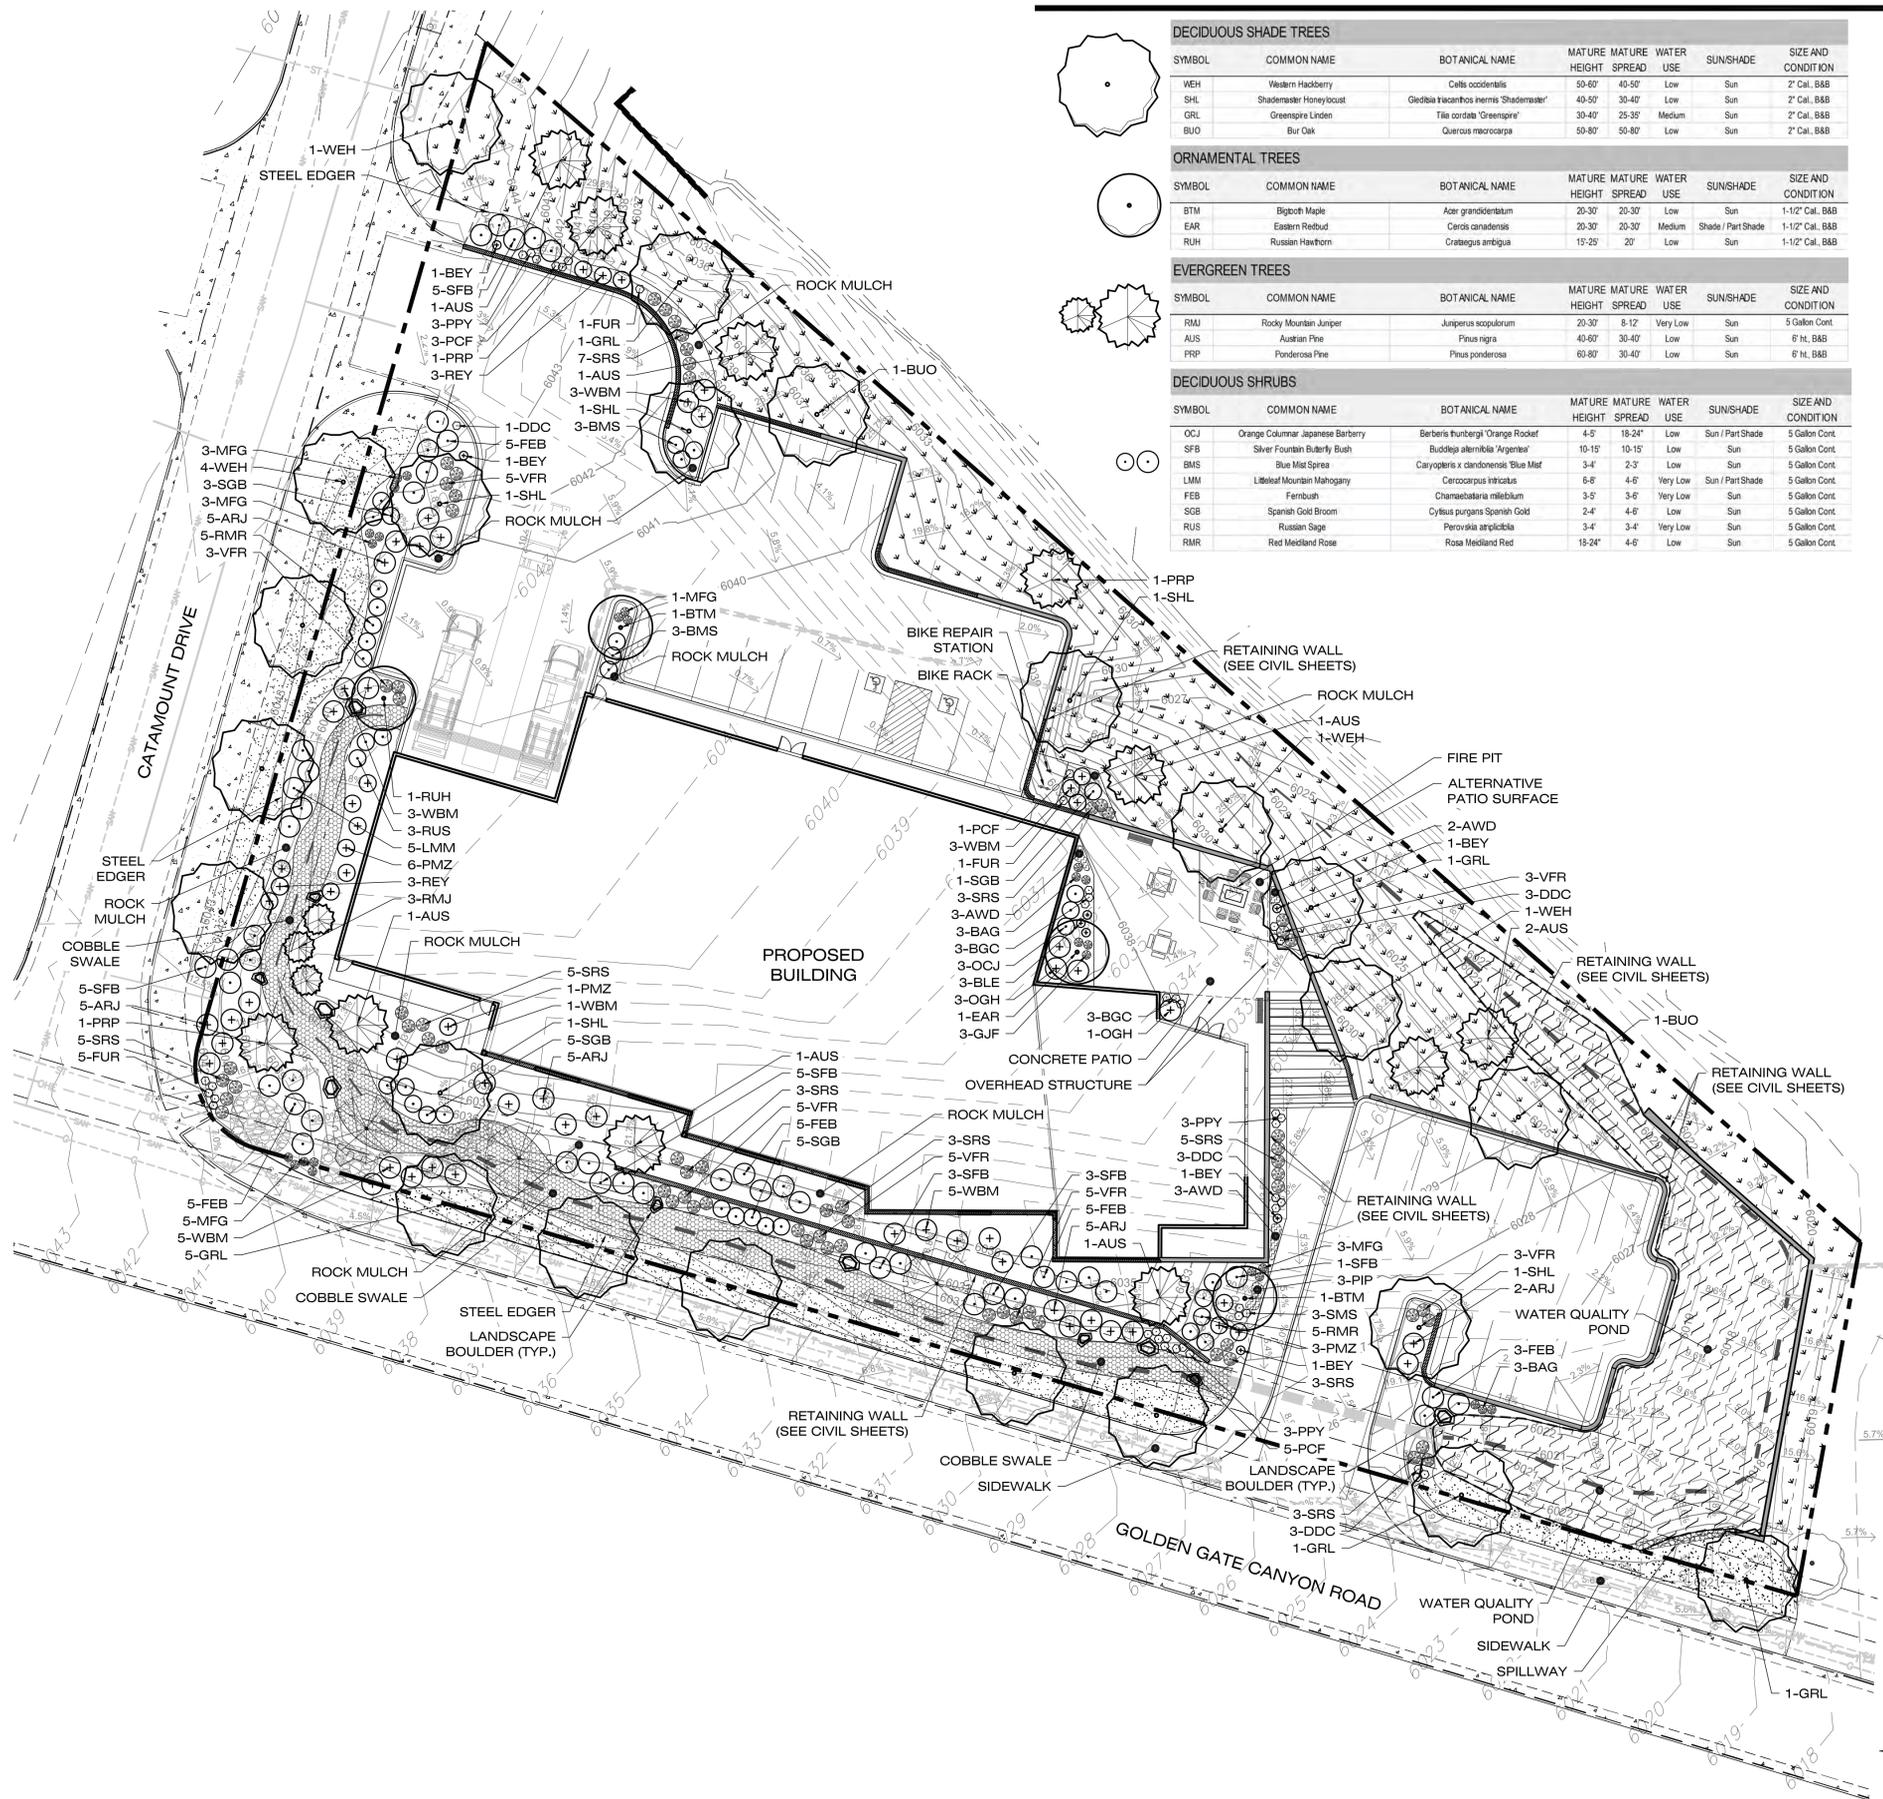

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 (303) 993-8111

COLORADO 811
 Call 3 business days in advance before you dig, grade, or excavate for the marking of underground member utilities.

OWNER
 AMY AND JORDAN JONES
 8800 BRICKYARD CIRCLE
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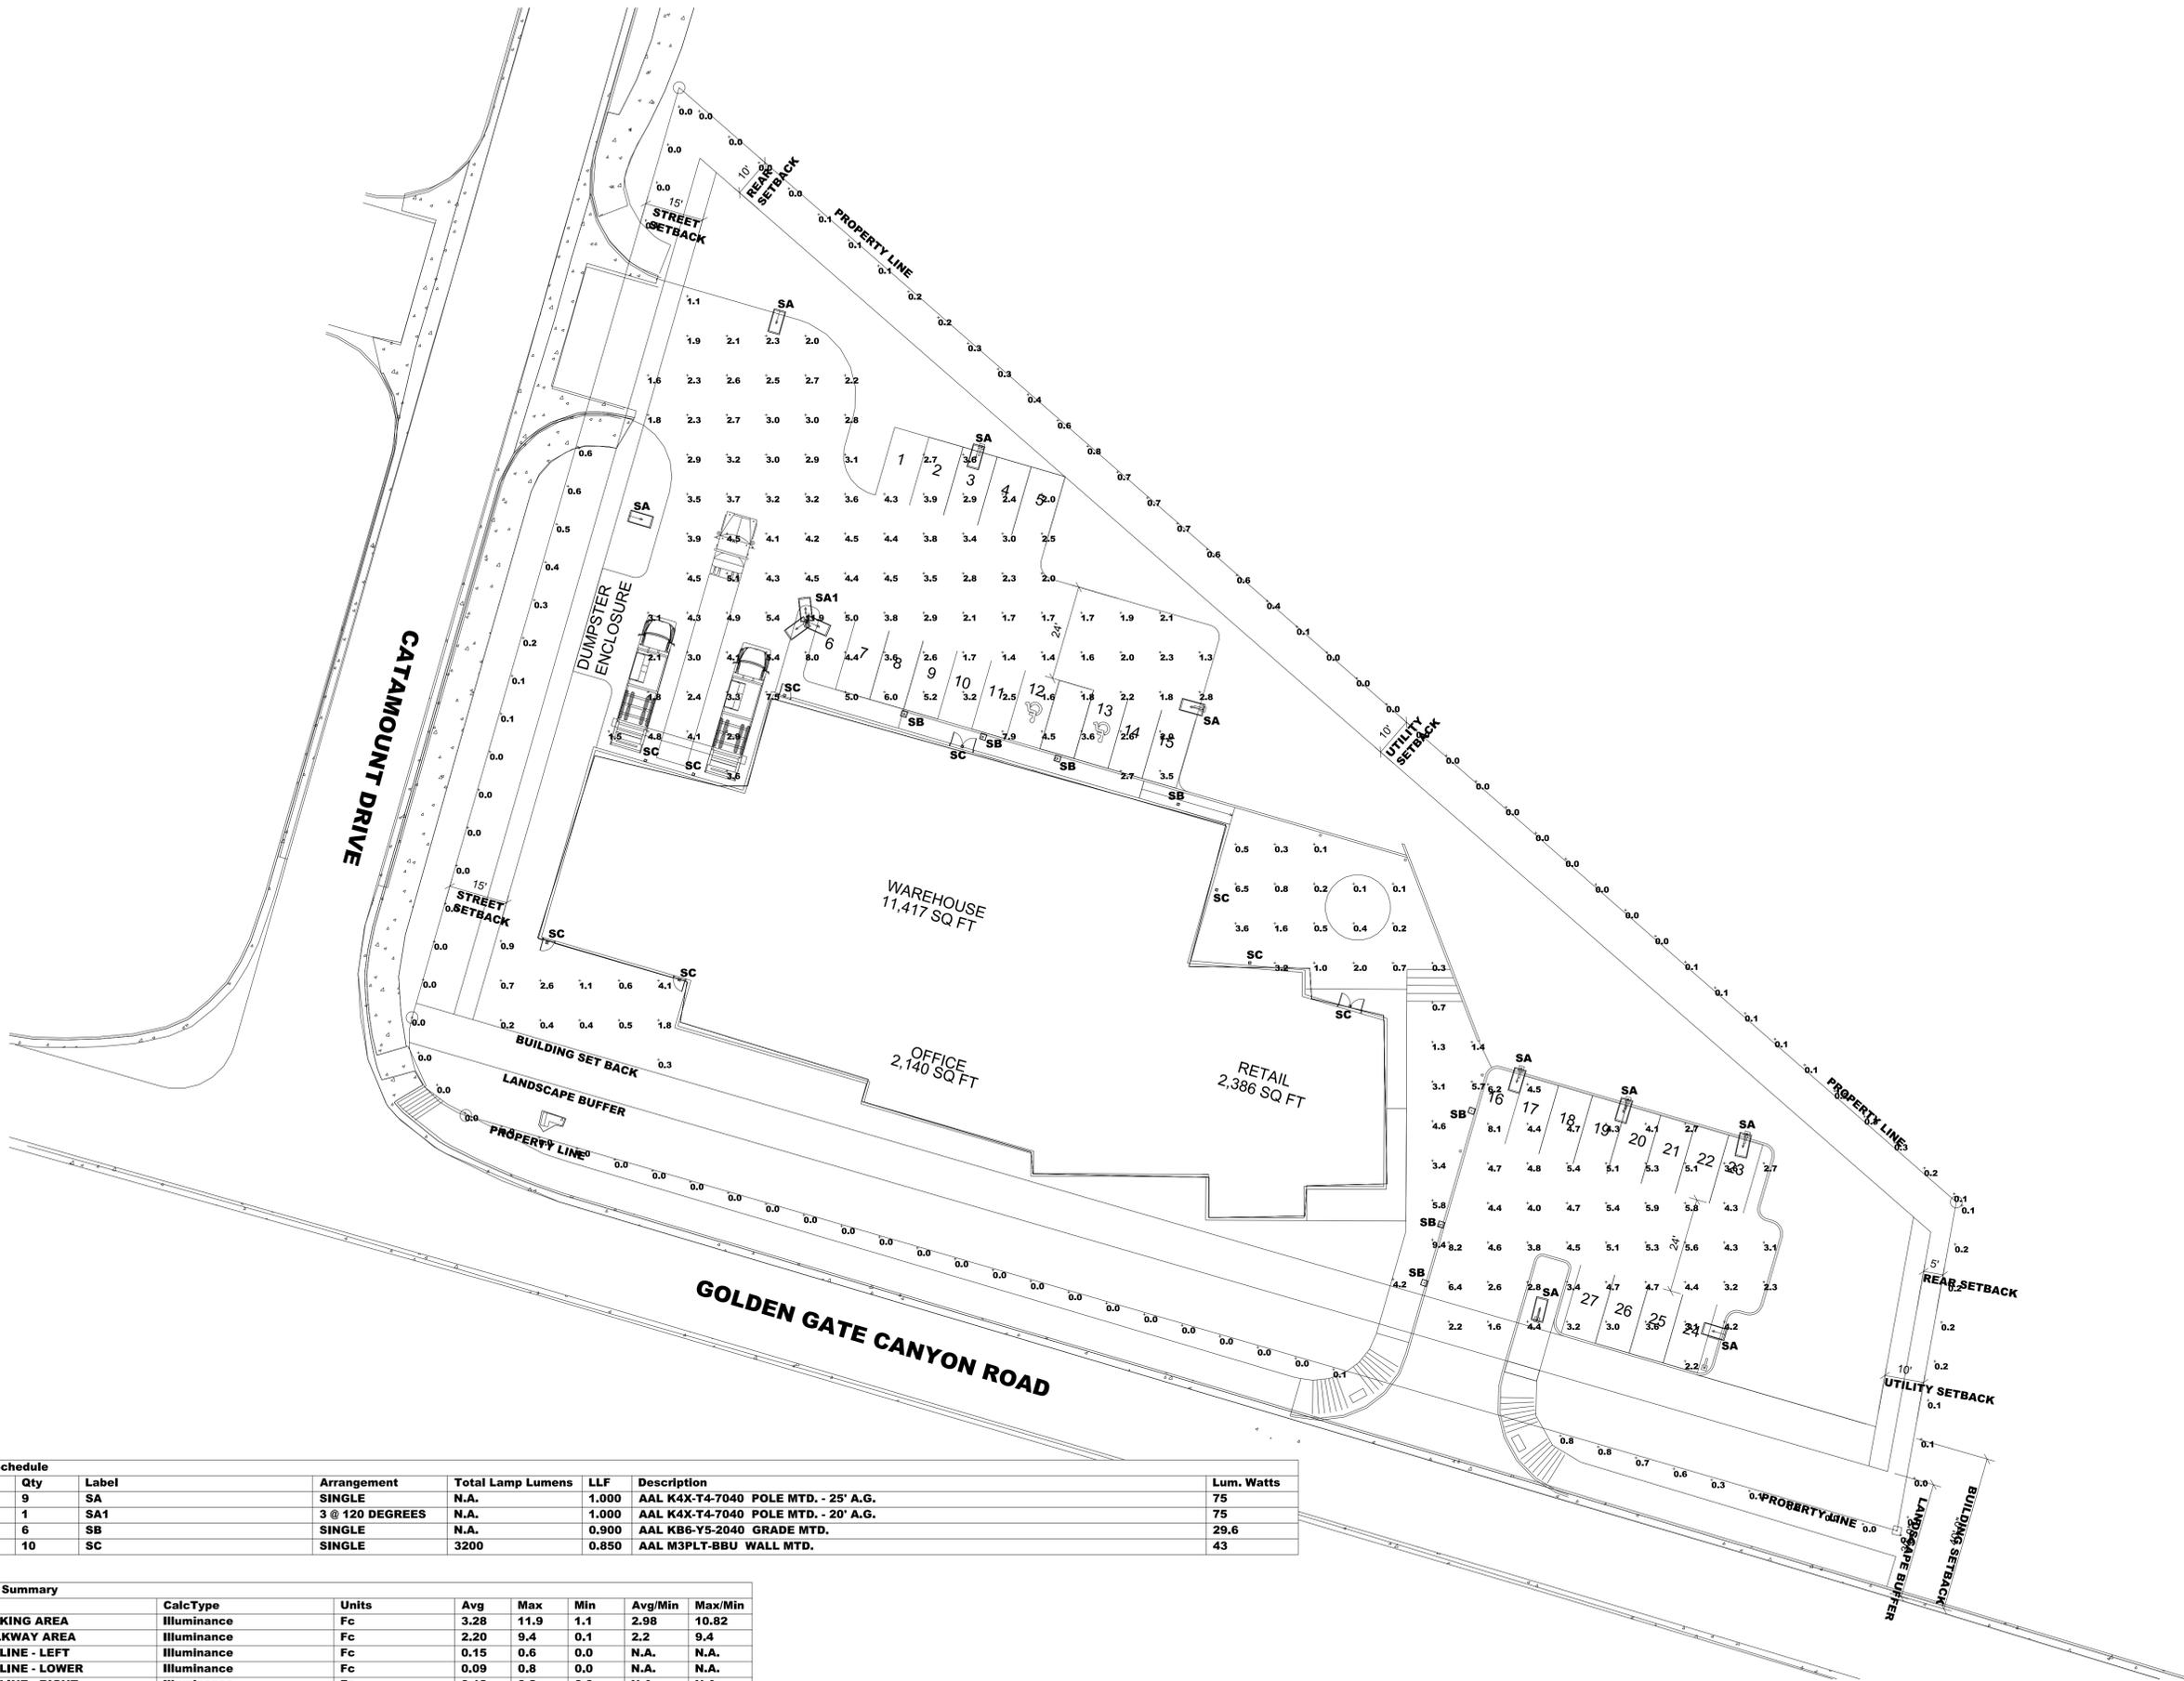
POWDER 7 WAREHOUSE
 20041 GOLDEN GATE CANYON RD.
 GOLDEN, CO 80403

REVISIONS
 1 07-07-17 CITY SUBMITTAL

KEY PLAN

SCALE: 1" = 20'
 DATE: 07-07-17
 STARTED BY:
 DRAWING TITLE:
LANDSCAPE PLAN
 SHEET NO.
L-1

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Symbol	Qty	Label	Arrangement	Total Lamp Lumens	LLF	Description	Lum. Watts
□	9	SA	SINGLE	N.A.	1.000	AAL K4X-T4-7040 POLE MTD. - 25' A.G.	75
○	1	SA1	3 @ 120 DEGREES	N.A.	1.000	AAL K4X-T4-7040 POLE MTD. - 20' A.G.	75
□	6	SB	SINGLE	N.A.	0.900	AAL K86-Y5-2040 GRADE MTD.	29.6
□	10	SC	SINGLE	3200	0.850	AAL M3PLT-BBU WALL MTD.	43

Label	CalcType	Units	Avg	Max	Min	Avg/Min	Max/Min
LARGE PARKING AREA	Illuminance	Fc	3.28	11.9	1.1	2.98	10.82
LARGE WALKWAY AREA	Illuminance	Fc	2.20	9.4	0.1	2.2	9.4
PROPERTY LINE - LEFT	Illuminance	Fc	0.15	0.6	0.0	N.A.	N.A.
PROPERTY LINE - LOWER	Illuminance	Fc	0.09	0.8	0.0	N.A.	N.A.
PROPERTY LINE - RIGHT	Illuminance	Fc	0.12	0.2	0.0	N.A.	N.A.
PROPERTY LINE - UPPER	Illuminance	Fc	0.20	0.8	0.0	N.A.	N.A.
SMALL PARKING AREA	Illuminance	Fc	4.33	8.2	1.6	2.71	5.13
SMALL PATIO AREA	Illuminance	Fc	1.13	4.1	0.2	5.65	4.1

1 SITE PHOTOMETRIC PLAN
SCALE: 1" = 20'-0"

OWNER

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GOLDEN, CO 80403

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LANDSCAPE ARCHITECT


OUTDOOR DESIGN GROUP
6690 WEBSTER STREET
ARVADA, CO 80002

INTERIOR ARCHITECT

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POWDER 7 WAREHOUSE

1101 CATAMOUNT DRIVE
GOLDEN, CO 80403

REVISIONS

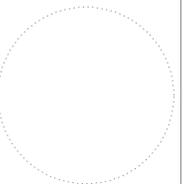DATE	DESCRIPTION
07/07/2017	DEVELOPMENT REVIEW

NOT FOR CONSTRUCTION
(DEVELOPMENT PLAN REVIEW)



SCALE: 1" = 20'-0"
DATE: 07/07/2017
STARTED BY:

DRAWING TITLE:
PHOTOMETRIC LIGHTING PLAN

SHEET NO.
E-1

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